## 5415 Crane Road, Ypsilanti, Michigan 48197

## OWNER

**Pittsfield Charter Township** 6201 W. Michigan Avenue Ann Arbor, Michigan 48108 (734) 822.3101

## PITTSFIELD TOWNSHIP PARK COMMISSION

#### Members:

Cleveland Chandler, Chairperson Theresa Tupacz, Vice Chair Patricia Stanton-Kawalec, Secretary **Deborah Lennington** Karen Zera

## PITTSFIELD TOWNSHIP PARKS AND RECREATION

Dan Cooperrider, Director (734) 822.2120

## **SURVEYOR**

Midwestern Consulting

3815 Plaza Drive Ann Arbor, MI 48108

t 734.995.0200

f 734.995.0599

## BENCH MARKS

1. RAILROAD SPIKE IN W. SIDE OF 35" OAK (#1001) LOCATED AT THE N.W. PROPERTY CORNER. ELEV.=819.47 NAVD 88

2. RAILROAD SPIKE IN E. SIDE OF UTILITY POLE LOCATED ON THE E. SIDE OF CART SHACK. ELEV.=829.18 NAVD 88

3. RAILROAD SPIKE IN E. SIDE OF 20" SHAGBARK HICKORY (#1050). LOCATED IN MIDDLE OF SITE, W. OF HIGH TENSION LINE. ELEV.=821.15 NAVD 88

4. P.K. NAIL IN E. SIDE OF UTILITY POLE LOCATED 60'± N. OF N.E. PROPERTY CORNER. ELEV.=799.41 NAVD 88

5. RAILROAD SPIKE IN E. SIDE OF UTILITY POLE LOCATED IN THE CENTER OF GOLF COURSE, 550'± W. OF MUNGER ROAD.

ELEV.=819.24 NAVD 88 6. T/BOLT WITH RIBBON ON N.W. SIDE OF TOWER LEG TO HIGH TENSION POWER LINE AT N. PROPERTY LINE.

7.) COORDINATES SHOWN ARE BASED ON LOCAL COORDINATE SYSTEM. UTILIZE THE FOLLOWING INFORMATION FOR CONVERSION TO STATE PLAN COORDINATE SYSTEM:

**CENTER SECTION 24** NORTH 1636.96' EAST 1915.47'

ELEV.=821.50 NAVD 88

 $E_{\frac{1}{4}}$  CORNER SECTION 24 NORTH 1582.20' EAST 4572.67'

MICHIGAN STATE PLANE COORDINATES (NAD 83 SOUTH ZONE)

**CENTER SECTION 24** NORTH 258,979.60' EAST 13,312,157.84' E ½ CORNER SECTION 24 NORTH 258,979.11' EAST 13,314,815.61'

## LEGAL DESCRIPTION

LEGAL DESCRIPTION OF A 46.60 ACRE PARCEL OF LAND LOCATED IN THE NE 1/4 OF SECTION 24, T3S, R6E, PITTSFIELD TOWNSHIP, WASHTENAW COUNTY, MICHIGAN

Beginning at the Center of Section 24, T3S, R6E, Pittsfield Township, Washtenaw County, Michigan; thence Northerly 313.98 feet along the North and South 1/4 line of said Section 24 and the centerline of Crane Road; thence Easterly deflecting 91°42' to the right 102.0 feet; thence Northerly deflecting 91°42' to the left 18.0 feet; thence Easterly deflecting 91°42' to the right 198.0 feet; thence Northerly deflecting 91°42' to the left 488.15 feet parallel with the North and South 1/4 line of said Section 24; thence Easterly deflecting 91°34' to the right 2359.80 feet along the North line of the South 50 acres of the Northeast 1/4 of said Section 24 and parallel with the East and West 1/4 line of said Section 24; thence Southerly deflecting 88°35'30" to the right 819.46 feet along the East line of said Section 24 and the centerline of Munger Road; thence Westerly deflecting 91°24'30" to the right 2657.53 feet along the East and West 1/4 line of said Section 24 to the Point of Beginning, being part of the Northeast 1/4 of said Section 24, T3S, R6E, Washtenaw County, Michigan.

Being more particularly described as (Survey):

thence N 00°22'43" W 313.98 feet along the N-S 1/4 line of said Section 24 and the centerline of Crane Road (66 feet wide);

thence S 88°49'10" E 102.00 feet; thence N 00°22'43" W 18.00 feet;

thence N 00°22'43" W 487.52 feet;

Subdivision No. 3 as recorded in Liber 32 of Plats, Pages 91-98, Subdivision No. 4 as recorded in Liber 34 of Plats, Pages 76-80,

thence S 00°13'52" E 819.37 feet along the East line of said Section 24 and the centerline of Munger Road (66 feet wide) to the E 1/4 Corner

thence N 88°49'10" W 2657.77 feet along the E-W 1/4 line of said T3S, R6E, Pittsfield Township, Washtenaw County, Michigan, and containing 46.60 acres of land, more or less. Being subject to the the Easterly 33.00 feet of Crane Road and being subject to other

Together with an easement for water line and underground electric cable over the following described property: Commencing at the Center of Section 24, 331.98 feet along the N-S 1/4 line of said Section 24 and the centerline of Crane Road; thence Easterly deflecting 91°42' to the right 142.0 feet for a Point of Beginning; thence Northerly deflection 91°42' to the left 10.0 feet; thence Easterly deflecting 91°42' to the right 158.0 feet; thence Southerly deflecting 88°18' to the right 10.0 feet parallel with the N-S 1/4 line of said Section 24; thence Westerly deflecting 91°42' to the right 158.0 feet to the Point of Beginning, being a part of the NE 1/4 of said Section24, T3S, R6E,

#### Being subject to:

Conservation Easement, as recorded in Liber 4637, Page 274, Washtenaw

Rights of the public or any governmental unit in any part of subject property taken, deeded, or used for street, road, or highway purposes. Easement in favor of The Detroit Edison Company, as recorded in Liber 598, Page 169, Washtenaw County Records.

Grant in favor of The Detroit Edison Company, as recorded in Liber 1 of Grants, Page 298, Washtenaw County Records.

Subject to underground drain as recorded in Liber 1567, Page 12, Washtenaw County Records.(for benefit of home at 5281 Crane Road)

Terms, conditions, and provisions regarding land division and farming rights contained in the instrument recorded in Liber 4637, Page 275, Washtenaw County Records.

1.) BEARINGS ARE BASED ON ASHFORD VILLAGE NO. 5 SUBDIVISION AS RECORDED IN LIBER 31 OF PLATS, PGS. 1-6, WASHTENAW COUNTY RECORDS.

2.) LEGAL DESCRIPTION TAKEN FROM ABSOLUTE TITLE COMPANY FILE NO. 62635, DATED JANUARY 5, 2009.

Beginning at the Center of Section 24, T3S, R6E, Pittsfield Township, Washtenaw County, Michigan;

thence S 88°49'10" E 198.08 feet;

thence S 88°49'04" E 2359.80 feet along the South line of Hickory Pointe Washtenaw County Records and along the South line of Hickory Pointe Washtenaw County Records;

of said Section 24; Section 24 and the North line of Ashford Village No. 5 Subdivision as recorded in Liber 31 of Plats, Pages 1-8, Washtenaw County Records to the POINT OF BEGINNING. Being a part of the NE 1/4 of Section 24, rights of the public over the Westerly 33.00 feet of Munger Road and easements and restrictions of record, if any.

T3S, R6E, Pittsfield Township, Washtenaw County, Michigan; thence Northerly Pittsfield Township, Washtenaw County, Michigan.

## NOTES:

## SHEET INDEX

S-17 Storm System Calculations M-1.1 Underground Plumbing Floor Plan and Plumbing Floor Plan S-18 Landscape Plan - West M-2.1 Mechanical HVAC Floor Plan S-19 Landscape Plan - East M-3.1 Mechanical Details and Schedules S-20 Right-of-Way Enlargement S-21 Right-of-Way Details E-1.0 Symbol List, Lighting Fixture Schedule and One Line Diaground Plumbing Floor Plan S-22 Site Details E-1.0 Electrical Site Plan S-23 Site Details E-2.1 Electrical Plans S-24 Planting Notes & Details S-25 Parking & Restroom Building Enlargements	Sheet #	Sheet Name		
S-02 Overall Site Plan S-03 Existing Conditions and Demolition Plan - West S-04 Existing Conditions and Demolition Plan - West S-05 Existing Tree Inventory S-06 Layout & Materials Plan - West S-07 Layout & Materials Plan - West S-08 SESC Plan - West S-09 SESC Plan - West S-09 SESC Plan - East S-10 Grading & Utilities Plan - East S-11 Grading & Utilities Plan - East S-12 Road and Path Plan & Profile S-13 Path Plan & Profile S-14 Stormwater Management Plan S-15 Pond Cross-Sections S-16 Storm Sewer Plan & Profile S-16 Sanitary Sewer Details S-17 Storm System Calculations S-29 Standard Sanitary Sewer Details S-20 Restroom Building Floor Plans & Schedules S-30 Standard Water Main Specifications S-31 Standard Water Main Specifications S-32 Standard Water Main Specifications S-33 Standard Water Main Specifications S-34 Standard Water Main Specifications S-36 Restroom Building Floor Plans & Schedules S-69 SESC Plan - East A-2.0 Restroom Building Floor Plans & Schedules S-16 Restroom Building Rof Framing Plan Restroom Building Rof Framing Plan Restroom Building Rof Plan Restroom Building Rof Plan S-18 Stormwater Management Plan A-4.0 Restroom Building Wall Sections & Details S-16 Storm Sewer Plan & Profile S-16 Storm Sewer Plan & Profile S-17 Storm System Calculations M-1.1 Underground Plumbing Floor Plan and Plumbing Floor Pla S-18 Landscape Plan - West M-2.1 Mechanical HVAC Floor Plan and Plumbing Floor Pla S-19 Landscape Plan - East M-3.1 Mechanical Details and Schedules S-20 Right-of-Way Enlargement S-21 Right-of-Way Enlargement S-22 Site Details S-23 Site Details S-24 Planting Notes & Details S-25 Parking & Restroom Building Enlargements	į.	Cover Sheet	S-27	Standard Soil Erosion Control Notes & Details
Existing Conditions and Demolition Plan - West   S-30   Standard Sanitary Sewer Details	S-01	Overall Existing Conditions Plan	S-28	Standard Earthwork Specifications
S-04 Existing Conditions and Demolition Plan - East S-05 Existing Tree Inventory S-32 Standard Water Main Details S-06 Layout & Materials Plan - West S-07 Layout & Materials Plan - East S-08 SESC Plan - West S-09 SESC Plan - East S-10 Grading & Utilities Plan - West S-11 Grading & Utilities Plan - East S-12 Road and Path Plan & Profile S-13 Path Plan & Profile S-14 Stormwater Management Plan S-15 Pond Cross-Sections S-16 Storm Sewer Plan & Profile S-16 Storm Sewer Plan & Profile S-17 Storm System Calculations S-18 Landscape Plan - West M-2.1 Mechanical Sheet Index, Abbreviation List, and Symbol List S-19 Landscape Plan - East M-3.1 Mechanical Details S-20 Right-of-Way Enlargement S-22 Site Details S-24 Planting Notes & Details S-24 Planting Notes & Details S-26 Parking & Restroom Building Fixure Schedule and Diagrams S-26 Parking & Restroom Building Fixure Schedule and Diagrams S-26 Parking & Restroom Building Fixure Schedule and Diagrams S-21 Right-of-Way Details S-22 Parking & Restroom Building Fixure Schedule and Diagrams S-25 Parking & Restroom Building Enlargements	S-02	Overall Site Plan	S-29	Standard Storm Sewer Details & Specifications
S-05 Existing Tree Inventory S-06 Layout & Materials Plan - West S-07 Layout & Materials Plan - East S-08 SESC Plan - West S-09 SESC Plan - East S-10 Grading & Utilities Plan - East S-11 Grading & Utilities Plan - East S-12 Road and Path Plan & Profiles S-13 Path Plan & Profile S-14 Stormwater Management Plan S-15 Pond Cross-Sections S-16 Sanitary & Water Plan & Profile S-16 Sanitary & Water Plan & Profiles S-17 Storm System Calculations S-18 Landscape Plan - West S-19 Landscape Plan - East S-20 Right-of-Way Enlargement S-21 Right-of-Way Details S-22 Site Details S-23 Site Details S-24 Planting Notes & Details S-24 Parking & Restroom Building Floor Plan Schedules S-26 Right-of-Way Enlargement S-26 Rayout & Materials Plan & Profile Plan Section Sect	S-03	Existing Conditions and Demolition Plan - West	S-30	Standard Sanitary Sewer Details
S-06 Layout & Materials Plan - West S-07 Layout & Materials Plan - East S-08 SESC Plan - West S-09 SESC Plan - East S-09 SESC Plan - East S-10 Grading & Utilities Plan - East S-11 Grading & Utilities Plan - East S-12 Road and Path Plan & Profile S-13 Path Plan & Profile S-14 Stormwater Management Plan S-15 Pond Cross-Sections S-16 Storm Sewer Plan & Profile S-16 Storm Sewer Plan & Profile S-17 Storm System Calculations S-18 Landscape Plan - West S-19 Landscape Plan - East M-3.1 Mechanical Details S-20 Right-of-Way Enlargement S-20 Right-of-Way Details S-21 Right-of-Way Details S-22 Site Details S-24 Planting Notes & Details S-25 Parking & Restroom Building Floor Plans S-26 Restroom Building Roof Framing Plan Restroom Building Roof Framing Plan Restroom Building Roof Plan Restroom Building Roof Plan Restroom Building Roof Plan Restroom Building Exterior Elevations & Building Section Restroom Building Exterior Elevations & Building Section Restroom Building Wall Sections & Details Restroom Building Roof Plan Restroom Building Exterior Elevations & Building Section Restroom Building Exterior Elevations & Building Section Restroom Building Roof Plan Restroom Build	<b>S-04</b>	Existing Conditions and Demolition Plan - East	S-31	Standard Sanitary Sewer Specifications
S-07 Layout & Materials Plan - East S-08 SESC Plan - West S-09 SESC Plan - East S-10 Grading & Utilities Plan - West S-11 Grading & Utilities Plan - East S-12 Road and Path Plan & Profiles S-13 Path Plan & Profile S-14 Stormwater Management Plan S-15 Pond Cross-Sections S-16 Storm Sewer Plan & Profile S-16 Sanitary & Water Plan & Profile S-17 Storm System Calculations S-18 Landscape Plan - East S-19 Landscape Plan - East S-20 Right-of-Way Enlargement S-21 Right-of-Way Details S-22 Site Details S-24 Planting Notes & Details S-25 Parking & Restroom Building Floor Plans & Schedules A-1.0 Restroom Building Roof Plan Restroom Building Roof Plan Restroom Building Roof Plan Restroom Building Exterior Elevations & Building Section A-2.0 Restroom Building Wall Sections & Details Restroom Building Floor Plan Sections Restroom Building Ploor Plan Restroom Building Roof Plan Restroom	S-05	Existing Tree Inventory	S-32	Standard Water Main Details
S-08 SESC Plan - West S-09 SESC Plan - East S-10 Grading & Utilities Plan - West S-11 Grading & Utilities Plan - East S-12 Road and Path Plan & Profile S-13 Path Plan & Profile S-14 Stormwater Management Plan S-15 Pond Cross-Sections S-16 Storm Sewer Plan & Profile S-16 Sanitary & Water Plan & Profile S-17 Storm System Calculations S-18 Landscape Plan - West S-19 Right-of-Way Details S-20 Right-of-Way Details S-21 Right-of-Way Details S-22 Site Details S-23 Site Details S-24 Planting Notes & Details S-25 Parking & Restroom Building Floor Plans & Schedules S-16 Restroom Building Roof Plan Restroom Building Roof Plan Restroom Building Roof Plan Restroom Building Exterior Elevations & Building Section Restroom Building Exterior Elevations & Building Section Restroom Building Interior Elevations & Details Restroom Building Interior Elevations & Details A-5.0 Restroom Building Interior Elevations & Detai	5-06	Layout & Materials Plan - West	S-33	Standard Water Main Specifications
S-09 SESC Plan - East A-2.0 Restroom Building Foundation Plan S-10 Grading & Utilities Plan - West Restroom Building Reflected Ceiling Plan S-11 Grading & Utilities Plan - East Restroom Building Roof Framing Plan S-12 Road and Path Plan & Profiles Restroom Building Roof Plan S-13 Path Plan & Profile A-3.0 Restroom Building Exterior Elevations & Building Section S-14 Stormwater Management Plan S-15 Pond Cross-Sections A-5.0 Restroom Building Wall Sections & Details S-16 Storm Sewer Plan & Profile S-16 Sanitary & Water Plan & Profile S-17 Storm System Calculations M-1.1 Underground Plumbing Floor Plan and Plumbing Floor Plan S-18 Landscape Plan - West M-2.1 Mechanical HVAC Floor Plan S-19 Landscape Plan - East M-3.1 Mechanical Details and Schedules S-20 Right-of-Way Enlargement S-21 Right-of-Way Details E-1.0 Symbol List, Lighting Fixture Schedule and One Line Diagr. S-22 Site Details E-1.1 Electrical Site Plan S-23 Site Details E-2.1 Electrical Details and Diagrams S-24 Planting Notes & Details S-25 Parking & Restroom Building Enlargements	5-07	Layout & Materials Plan - East		
S-10 Grading & Utilities Plan - West S-11 Grading & Utilities Plan - East S-12 Road and Path Plan & Profiles S-13 Path Plan & Profile S-14 Stormwater Management Plan S-15 Pond Cross-Sections S-16 Storm Sewer Plan & Profile S-16 Sanitary & Water Plan & Profiles S-17 Storm System Calculations S-18 Landscape Plan - West S-19 Landscape Plan - East S-20 Right-of-Way Enlargement S-21 Right-of-Way Details S-22 Site Details S-23 Parking & Restroom Building Reflected Ceiling Plan Restroom Building Roof Plan Restroom Building Roof Plan Restroom Building Reflected Ceiling Plan Restroom Building Roof Plan Restroom Building Roof Plan Restroom Building Roof Plan Restroom Building Reflected Ceiling Plan Restroom Building Roof Plan Rest	S-08	SESC Plan - West	A-1.0	Restroom Building Floor Plans & Schedules
S-11 Grading & Utilities Plan - East S-12 Road and Path Plan & Profiles S-13 Path Plan & Profile S-14 Stormwater Management Plan S-15 Pond Cross-Sections S-16 Storm Sewer Plan & Profile S-16 Sanitary & Water Plan & Profile S-17 Storm System Calculations S-18 Landscape Plan - West S-19 Landscape Plan - East S-20 Right-of-Way Enlargement S-21 Right-of-Way Details S-22 Site Details S-23 Site Details S-24 Planting Notes & Details S-25 Parking & Restroom Building Roof Framing Plan Restroom Building Roof Plan Restroom Building Rofetion Restroo	5-09	SESC Plan - East	A-2.0	Restroom Building Foundation Plan
S-11 Grading & Utilities Plan - East S-12 Road and Path Plan & Profiles S-13 Path Plan & Profile S-14 Stormwater Management Plan S-15 Pond Cross-Sections S-16 Storm Sewer Plan & Profile S-16 Sanitary & Water Plan & Profile S-17 Storm System Calculations S-18 Landscape Plan - West S-19 Landscape Plan - East S-20 Right-of-Way Enlargement S-21 Right-of-Way Details S-22 Site Details S-24 Planting Notes & Details S-25 Parking & Restroom Building Roof Framing Plan Restroom Building Roof Plan Restroom Buildi	S-10	Grading & Utilities Plan - West		Restroom Building Reflected Ceiling Plan
S-13 Path Plan & Profile S-14 Stormwater Management Plan S-15 Pond Cross-Sections S-16 Storm Sewer Plan & Profile S-16a Sanitary & Water Plan & Profiles S-17 Storm System Calculations S-18 Landscape Plan - West S-19 Landscape Plan - East S-20 Right-of-Way Enlargement S-21 Right-of-Way Details S-22 Site Details S-23 Site Details S-24 Planting Notes & Details S-25 Parking & Restroom Building Exterior Elevations & Building Section A-3.0 Restroom Building Exterior Elevations & Building Section A-4.0 Restroom Building Exterior Elevations & Details A-4.0 Restroom Building Exterior Elevations & Building Section A-4.0 Restroom Building Enlargement Building Exterior Elevations & Building Exterior Elevations & Building Section A-4.0 Restroom Building Enlargement Building Exterior Elevations & Details A-5.0 Restroom Building Exterior Building Exterior Elevations & Details A-5.0 Restroom Building Exterior Building Exterior Building Exterior Building Exterior Elevation A-4.0 Restroom Building Enlargement A-5.0 Restroom Building Exterior Building Exterior Elevation A-4.0 Restroom Building Exterior Elevation A-5.0 Restroom Building Exterior Elevati	<b>S-11</b>	·=		Restroom Building Roof Framing Plan
S-14 Stormwater Management Plan A-4.0 Restroom Building Wall Sections & Details S-15 Pond Cross-Sections A-5.0 Restroom Building Interior Elevations & Details S-16 Storm Sewer Plan & Profile S-16a Sanitary & Water Plan & Profiles M-0.1 Mechanical Sheet Index, Abbreviation List, and Symbol List S-17 Storm System Calculations M-1.1 Underground Plumbing Floor Plan and Plumbing Floor Plan S-18 Landscape Plan - West M-2.1 Mechanical HVAC Floor Plan S-19 Landscape Plan - East M-3.1 Mechanical Details and Schedules S-20 Right-of-Way Enlargement S-21 Right-of-Way Details E-1.0 Symbol List, Lighting Fixture Schedule and One Line Diaground Plumbing Floor Plan S-22 Site Details E-1.1 Electrical Site Plan S-23 Site Details E-2.1 Electrical Plans S-24 Planting Notes & Details S-25 Parking & Restroom Building Enlargements	<b>S-12</b>	Road and Path Plan & Profiles		Restroom Building Roof Plan
S-15 Pond Cross-Sections A-5.0 Restroom Building Interior Elevations & Details S-16 Storm Sewer Plan & Profile S-16a Sanitary & Water Plan & Profiles M-0.1 Mechanical Sheet Index, Abbreviation List, and Symbol List S-17 Storm System Calculations M-1.1 Underground Plumbing Floor Plan and Plumbing Floor Plan S-18 Landscape Plan - West M-2.1 Mechanical HVAC Floor Plan S-19 Landscape Plan - East M-3.1 Mechanical Details and Schedules S-20 Right-of-Way Enlargement S-21 Right-of-Way Details E-1.0 Symbol List, Lighting Fixture Schedule and One Line Diagrams S-22 Site Details E-1.1 Electrical Site Plan S-23 Site Details E-2.1 Electrical Plans S-24 Planting Notes & Details E-3.1 Electrical Details and Diagrams S-25 Parking & Restroom Building Enlargements	S-13	Path Plan & Profile	A-3.0	Restroom Building Exterior Elevations & Building Section
S-15 Pond Cross-Sections A-5.0 Restroom Building Interior Elevations & Details S-16 Storm Sewer Plan & Profile S-16a Sanitary & Water Plan & Profiles M-0.1 Mechanical Sheet Index, Abbreviation List, and Symbol List S-17 Storm System Calculations M-1.1 Underground Plumbing Floor Plan and Plumbing Floor Plan S-18 Landscape Plan - West M-2.1 Mechanical HVAC Floor Plan S-19 Landscape Plan - East M-3.1 Mechanical Details and Schedules S-20 Right-of-Way Enlargement S-21 Right-of-Way Details E-1.0 Symbol List, Lighting Fixture Schedule and One Line Diaground Plumbing Floor Plan S-22 Site Details E-1.1 Electrical Site Plan S-23 Site Details E-2.1 Electrical Plans S-24 Planting Notes & Details E-3.1 Electrical Details and Diagrams S-25 Parking & Restroom Building Enlargements	S-14	Stormwater Management Plan	A-4.0	Restroom Building Wall Sections & Details
S-16a Sanitary & Water Plan & Profiles M-0.1 Mechanical Sheet Index, Abbreviation List, and Symbol List S-17 Storm System Calculations M-1.1 Underground Plumbing Floor Plan and Plumbing Floor Plan S-18 Landscape Plan - West M-2.1 Mechanical HVAC Floor Plan Mechanical Details and Schedules M-3.1 Mechanical Details and Schedules Mechanical HVAC Floor Plan Mechanical HV	S-15	<del>-</del>	A-5.0	Restroom Building Interior Elevations & Details
S-17 Storm System Calculations M-1.1 Underground Plumbing Floor Plan and Plumbing Floor Plan S-18 Landscape Plan - West M-2.1 Mechanical HVAC Floor Plan S-19 Landscape Plan - East M-3.1 Mechanical Details and Schedules S-20 Right-of-Way Enlargement S-21 Right-of-Way Details E-1.0 Symbol List, Lighting Fixture Schedule and One Line Diaground Plumbing Floor Plan S-22 Site Details E-1.0 Electrical Site Plan S-23 Site Details E-2.1 Electrical Plans S-24 Planting Notes & Details S-25 Parking & Restroom Building Enlargements	S-16	Storm Sewer Plan & Profile		
S-17 Storm System Calculations M-1.1 Underground Plumbing Floor Plan and Plumbing Floor Plan S-18 Landscape Plan - West M-2.1 Mechanical HVAC Floor Plan S-19 Landscape Plan - East M-3.1 Mechanical Details and Schedules S-20 Right-of-Way Enlargement S-21 Right-of-Way Details E-1.0 Symbol List, Lighting Fixture Schedule and One Line Diaground Plumbing Floor Plan S-22 Site Details E-1.1 Electrical Site Plan S-23 Site Details E-2.1 Electrical Plans S-24 Planting Notes & Details S-25 Parking & Restroom Building Enlargements	S-16a	Sanitary & Water Plan & Profiles	M-0.1	Mechanical Sheet Index, Abbreviation List, and Symbol List
S-19 Landscape Plan - East M-3.1 Mechanical Details and Schedules S-20 Right-of-Way Enlargement S-21 Right-of-Way Details E-1.0 Symbol List, Lighting Fixture Schedule and One Line Diagrams S-22 Site Details E-1.1 Electrical Site Plan S-23 Site Details E-2.1 Electrical Plans S-24 Planting Notes & Details E-3.1 Electrical Details and Diagrams S-25 Parking & Restroom Building Enlargements	S-17		M-1.1	Underground Plumbing Floor Plan and Plumbing Floor Plan
S-19 Landscape Plan - East M-3.1 Mechanical Details and Schedules S-20 Right-of-Way Enlargement S-21 Right-of-Way Details E-1.0 Symbol List, Lighting Fixture Schedule and One Line Diagrams S-22 Site Details E-1.1 Electrical Site Plan S-23 Site Details E-2.1 Electrical Plans S-24 Planting Notes & Details E-3.1 Electrical Details and Diagrams S-25 Parking & Restroom Building Enlargements	S-18	Landscape Plan - West	M-2.1	Mechanical HVAC Floor Plan
S-20 Right-of-Way Enlargement S-21 Right-of-Way Details S-22 Site Details S-23 Site Details S-24 Planting Notes & Details S-25 Parking & Restroom Building Enlargements  E-1.0 Symbol List, Lighting Fixture Schedule and One Line Diagrams E-1.1 Electrical Site Plan E-2.1 Electrical Plans E-3.1 Electrical Details and Diagrams	S-19	· · · · · · · · · · · · · · · · · · ·	M-3.1	Mechanical Details and Schedules
S-21 Right-of-Way Details E-1.0 Symbol List, Lighting Fixture Schedule and One Line Diagrams S-22 Site Details E-1.1 Electrical Site Plan S-23 Site Details E-2.1 Electrical Plans S-24 Planting Notes & Details E-3.1 Electrical Details and Diagrams S-25 Parking & Restroom Building Enlargements	S-20	· · · · · · · · · · · · · · · · · · ·		
S-22 Site Details E-1.1 Electrical Site Plan S-23 Site Details E-2.1 Electrical Plans S-24 Planting Notes & Details E-3.1 Electrical Details and Diagrams S-25 Parking & Restroom Building Enlargements	5-21		E-1.0	Symbol List, Lighting Fixture Schedule and One Line Diagran
S-24 Planting Notes & Details E-3.1 Electrical Details and Diagrams S-25 Parking & Restroom Building Enlargements			E-1.1	Electrical Site Plan
S-24 Planting Notes & Details E-3.1 Electrical Details and Diagrams S-25 Parking & Restroom Building Enlargements	S-23	Site Details	E-2.1	Electrical Plans
S-25 Parking & Restroom Building Enlargements		Planting Notes & Details	E-3.1	Electrical Details and Diagrams
T — T	<b>S-26</b>	Fire Protection Plan		


#### Seal

## Landscape Architect / Engineer

B R (i) Beckett&Raeder

> Beckett & Raeder, Inc. Ann Arbor, MI 48103 734 663.2622 ph 734 663.6759 fx

## Architect

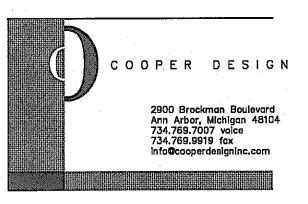

## Mechanical / Electrical Engineer




BERBIGLIA ASSOCIATES INC. CONSULTING ENGINEERS


36400 West 12 Mile Road Farmington Hills, Michigan 48331 (248) 489-3100 FAX (248) 489-3161

## Structural Engineer

Structural Design Inc. 275 E. Liberty Ann Arbor, MI 48104

734-213-6091

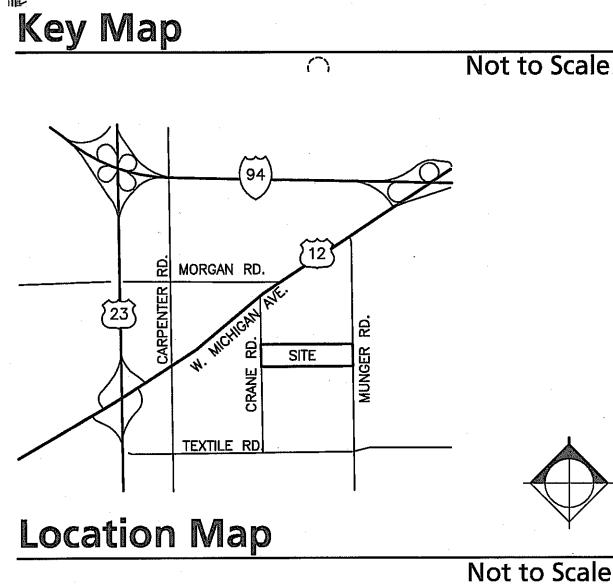

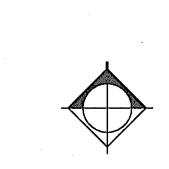

# 38'-8" 29 CMU BOLLARD 3 OVERHEAD DOOR-MENS TOILET **WOMENS TOILET** UTILITY ROOM WALLHYDRANT O P E N P O R C H \_\_\_\_\_\_\_\_\_\_

FOUNTAIN

TURN-A-ROUND

## TOILET ACCESSORIES SCHEDULE

IEM IO.	ROOM & ACCESSORIES	QUANT.	MANUFACTURER	MODEL NUMBER	FINISH	NOTES
W	OMENS TOILET					
1	FRAMED MIRROR	1	BRADLEY	780-2436	STAINLESS STEEL FRAME	1
2	TOILET PAPER DISPENSER	2	ROYCE ROLLS	TP-2	STAINLESS STEEL, SATIN	3
4	HORZ. GRAB BARS - 42"	1	BRADLEY	812-2 SERIES	STAINLESS STEEL	
5	HORZ. GRAB BARS - 36"	1	BRADLEY	812-2 SERIES	STAINLESS STEEL	
6	VERTICAL GRAB BAR - 18"	1	BRADLEY	812-2 SERIES	STAINLESS STEEL	
7	ELECTRIC HAND DRYER	1	EXCELL	XL-SB	STAINLESS STEEL	2, 7
8	CHANGING STATION	1	BRADLEY	9612	HIGH DENSITY POLYETHYLENE	6
MI	NS TOILET	<u> </u>				
MI 1	INS TOILET FRAMED MIRROR	1	BRADLEY	780-2436	STAINLESS STEEL FRAME	1
	7	1 1	BRADLEY ROYCE ROLLS	780-2436 TP-2	STAINLESS STEEL FRAME STAINLESS STEEL, SATIN	1 3
1	FRAMED MIRROR			+		· .
1 2	FRAMED MIRROR TOILET PAPER DISPENSER	1	ROYCE ROLLS	TP-2	STAINLESS STEEL, SATIN	· .
1 2 4	FRAMED MIRROR TOILET PAPER DISPENSER HORZ, GRAB BARS - 42"	1	ROYCE ROLLS BRADLEY	TP-2 812-2 SERIES	STAINLESS STEEL, SATIN STAINLESS STEEL	
1 2 4 5	FRAMED MIRROR  TOILET PAPER DISPENSER  HORZ, GRAB BARS - 42"  HORZ, GRAB BARS - 36"	1 1 1	ROYCE ROLLS BRADLEY BRADLEY	TP-2 812-2 SERIES 812-2 SERIES	STAINLESS STEEL, SATIN STAINLESS STEEL STAINLESS STEEL	

#### **TOILET ACCESSORIES SCHEDULE NOTES**

- WALL MOUNTED MIRROR WITH THEFT RESISTANT MOUNTING. TO BE MOUNTED PER MICHIGAN BARRIER-FREE DESIGN REQUIREMENTS.
- 2 PROVIDE CONCEALED WIRING AND POWER FOR ELECTRIC HAND
- 3 LOCK & CLIP NOT REQUIRED; TO BE PROVIDED BY OWNER.
- 4 VERIFY MOUNTING HEIGHT; TO MEET MICHIGAN BARRIER-FREE
- 6 SURFACE MOUNTED; VERIFY BARRIER-FREE MOUNTING HEIGHT.
- STEEL COVER.

#### ROOM FINISH SCHEDULE

ROOM NAME	FLOOR	BASE	CEILING	CEILING		WALLS			
		TYPE	MATL	FINISH	NORTH	EAST	SOUTH	WEST	
GRADE LEVEL	·								
MENS TOILET	CFS	NONE	PLY-C	ST	СМИ-Р	CMU-P	CMU-P	СМИ-Р	1
WOMENS TOILET	CFS	NONE	PLY-C	ST	СМО-Р	CMU-P	CMU-P	CMU-P	1
							*****	<del></del>	
UTILITY ROOM	CFS	NONE	NO-C	STS	CMU-P	CMU-P	CMU-P	CMU-P	2

#### **ABBREVIATIONS**

- LIGHT BROOMED CONCRETE FLOOR; WITH CLEAR HARDENER AND SEALER (STAIN
- PLY-C MDO PLYWOOD CEILING WITH WOOD BATTENS AND WOOD EDGE TRIM: PLYWOOD 1/2" THICK, PAINT.
- EXPOSED STANDARD CMU; USE BLOCK FILLER AND PAINT.
- NO CEILING; EXPOSED ROOF TRUSSES AND

PROVIDE WOOD BLOCKING ABOVE PLYWOOD CEILING AS NECESSARY TO ACCOMMODATE PANELING LAYOUT AND

FINISH SCHEDULE NOTES

MANUFACTURER'S STANDARD SELECTION OF TO SECURE LIGHT FIXTURES, VENTS, EXHAUST

**GENERAL FINISH NOTES** 

A COLORS TO BE SELECTED BY ARCHITECT FROM

PROVIDE WOOD BLOCKING AS NECESSARY TO MOUNT LIGHT FIXTURES AND OVERHEAD DOOR TRACKS.

#### DOOR SCHEDULE

DOOR NUMBER DOOR TYPE PETERIOR DOOR DESCRIPTION FRAME TYPE DOOR SIZE FRAME SIZE THICKNESS GLAZING THRESHOLD SET SIGNAGE FINISH DOOR DOOR NOTES  101 1 A EXTERIOR HOLLOW METAL FLUSH DOOR HOLLOW METAL 3'-0" X 7'-0" 3'-4" X 7'-4" 13/4" NONE ALUMINUM 1 RS PAINTED 1,3  102 1 A EXTERIOR HOLLOW METAL FLUSH DOOR HOLLOW METAL 3'-0" X 7'-0" 3'-4" X 7'-4" 13/4" NONE ALUMINUM 1 RS PAINTED 1  103 1 A EXTERIOR HOLLOW METAL FLUSH DOOR HOLLOW METAL 7'-0" X 7'-5" VIF 3'-4" X 7'-4" 13/4" NONE ALUMINUM 2 RS PAINTED 1  104 1 B EXTERIOR MANUAL SECTIONAL OVERHEAD DOOR SIM WOOD/MASONRY 8'-0" X 8'-0" NA 13/4" NONE SLAB STD PAINTED 2												
102 1 A EXTERIOR HOLLOW METAL FLUSH DOOR HOLLOW METAL 3'-0" X 7'-0" 3'-4" X 7'-4" 13/4" NONE ALUMINUM 1 RS PAINTED 1  103 1 A EXTERIOR HOLLOW METAL FLUSH DOOR HOLLOW METAL 7'-0" X 7'-5" VIF 3'-4" X 7'-4" 13/4" NONE ALUMINUM 2 RS PAINTED 1				 DOOR DESCRIPTION	FRAME TYPE	DOOR SIZE	 1	GLAZING	THRESHOLD	*	SIGNAGE	 DOOR NOTES
102 1 A EXTERIOR HOLLOW METAL FLUSH DOOR HOLLOW METAL S'-0" X 7'-0" 3'-4" X 7'-4" 13/4" NONE ALUMINUM 1 RS PAINTED 1 103 1 A EXTERIOR HOLLOW METAL FLUSH DOOR HOLLOW METAL 7'-0" X 7'-5" VIF 3'-4" X 7'-4" 13/4" NONE ALUMINUM 2 RS PAINTED 1	404	T 4		 Lucil ciu Mezil cultura		T 21 20 14 21 22	 1		,			
103 1 A EXTERIOR HOLLOW METAL FLUSH DOOR HOLLOW METAL 7'-0" X 7'-5" VIF 3'-4" X 7'-4" 13/4" NONE ALUMINUM 2 RS PAINTED 1		1	A .				 			1		 1,3
ALOMINON A TO TAINIED I		1	A				 			1		 1
		-	A .				 				R5	 1

**GENERAL TOILET ACCESSORIES NOTES** 


VERY DEPENDING ON MANUFACTURER SELECTED.

A ALL TOILET ROOMS ARE TO MEET MICHIGAN BARRIER-FREE

DESIGN REQUIREMENTS. THE CONTRACTOR IS RESONSIBLE FOR VERIFYING ALL MOUNTING HEIGHTS BEFORE

INSTALLATION TO INSURE COMPLIANCE. MOUNTING MAY

#### DOOR TYPES

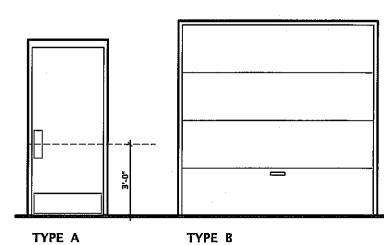

#### DOOR SCHEDULE NOTES

- 1 RS = ROOM SIGN: EXTERIOR TO COMPLY WITH MICHIGAN BARRIER-FREE DESIGN REQUIREMENTS. SIGNAGE TO BE MOUNTED ON STAND-OFFS BECAUSE SIGNAGE IS LOCATED ON UNEVEN ASHLAR STONE.
- 2 OVERHEAD DOOR TO BE MANUALLY OPERATED. TRACKS TO BE MOUNTED TO UNDERSIDE OF EXPOSED ROOF TRUSS FRAMING. PROVIDE BLOCKING AS NECESSARY, JAMB AND HEAD TRIM TO BE SIMULATED WOOD TRIM, PAINTED. DOOR TO BE LOCKABLE FROM THE INTERIOR WITH A KEY.
- 3 ALL HOLLOW METAL DOORS AND FRAMES TO BE GALVANIZED.

#### **GENERAL DOOR NOTES**

- ALL DOORS TO MEET BARRIER-FREE DESIGN REQUIRMENTS.
- PROVIDE BARRIER-FREE EXIT DOOR SIGNAGE AND ROOM SIGNAGE IN ACCORDANCE WITH MICHIGAN BARRIER-FREE DESIGN REQUIRMENTS.
- C SEE HARDWARE SPECIFICATION FOR DOOR HARDWARE SETS.

#### **DRAWING NOTES**

- 1 New concrete walk; see site drawing for details.
- 2 Concrete parking pad for maintenance vehicle: see site drawing for details.
- 3 8" Dia. steel bollard with protective sleeve.
- 4 3 Bowl barrier-free drinking fountain.
- 5 Porch pier.
- 6 Overhead toilet partition brace.
- 7 Typical floor drain.
- 8 Floor sink with splash guards and wall mounted utility shelf. See plumbing plans.

# R (i)

Beckett&Raeder Landscape Architecture Planning & Engineering

> Beckett & Raeder, Inc. 535 West William, Suite 101 Ann Arbor, MI 48103 734 663.2622 ph 734 663.6759 f

# Consultants COOPER DESIGN

Project Title

Pittsfield Township Parks

HICKORY WOODS PARK

PHASE 1b IMPROVEMENTS

Parks Commission

Pittsfield Township, MI

Restroom Building

Sheet Title

FLOOR PLAN

& SCHEDULES

2900 Brockman Boulevard Ann Arbor, Michigan 48104

734.769.7007 voice 734.769.9919 fax info@cooperdesigninc.con

#### **BUILDING DATA**

3'-6"

FLOOR PLAN

Exterior masonary dimensions are to CMU, not to

simulated stone veneer. The stone veneer thickness

varies; typically it is 2 1/4", including a 1/2" setting

bed. Layout is generally to the CMU surfaces.

See Grading & Utilites Plan - West, Sheet S-10 for Finished Floor Elevation for the Restroom Building.

Floor slab set at one elevation. Slope slab to floor

SCALE 1/4" = 1'- 0"

FLOOR ELEVATION

drains at all rooms.

LAYOUT

COVERED AREA 1005 GSF

670 GSF ENCLOSED AREA **TOILET ROOM AREA** 

160 NSF, EACH - 320 NSF TOTAL

244 NSF UTILITY ROOM AREA

#### **BUILDING DESCRIPTION**

The building's principal use is to provide public toilets for park users. This is intended to be a seasonal, summer use only. The building will also be used by park staff to maintain the toilet rooms and the park, in general.

The utility room will house the site electrical service and any future site lighting controls. Any future irrigation controls and backflow prevention would be housed here, as well. The parks department intends to store a gasoline powered 'ATV like' maintenance vehicle in the utility room. Container gas will be stored elsewhere.

The public toilet rooms are to be fully barrier-free accessible.

#### **BUILDING CODE** APPROACH TO COMPLIANCE

#### Applicable Code: Michigan Building Code - 2006

USE GROUP: 'U' UTILITY, Private Garage (due to storage of ATV)

CONSTRUCTION TYPE: TYPE II-B Non-combustible masonry exterior walls, masonry interior walls/partitions, light gauge metal stud interior partitions, non-combustible light gauge metal truss

#### No fire separation of Utility Room required.

ALLOWABLE HEIGHT & AREA: 2 STY - 8,500SF Proposed 670GSF, easily within height and area requirements.

BARRIER-FREE ACCESSIBILITY: The public toilet rooms are intended to be fully accessible in compliance with the Michigan Building Code, Barrier-free Design Requirements.

FIRE SUPPRESSION: The building will not have a fire suppression system. It will be accessible by fire fighting equipment from the adjacent entry drive turn-a-round.

#### **SELECT MATERIALS**

Soil Supporting **Foundations & Slabs** 

1,000 psf minimum allowable bearing capacity (to be field verified prior to construction)

Concrete Footings

Concrete Slab-on-Grade

(6%+/- 1% at all concrete, builiding not conditioned)

ASTM A-615 (grade 60)

ASTM A-185 flat sheets

3,000 psi @ 28 days.

4,000 psi @ 28 days

Reinforcing Bar Welded Wire Fabric

CMU ASTM C-90 & C-145 Normal weight (assembly strength f'm=1500 psi) ASTM C-270, Type M Mortar Below Grade

Mortar Typical Mortar Sim Stone

ASTM C-270, Type S ASTM C-270, Type N

ASTM C-476 Grout in CMU Cores (3000 psi at 28 days)

**Grout Below Plates** Sikadur 42 Grout Pak (15,000 psi) ASTM A992 - Fy=50 ksi Structural Steel

**Epoxy Bolts** 

HAS-E Standard ISO 898 Class 5.8 threaded rod, drilled and embedded with Hilti Hit HY 150 MAX Adhesive. provide screen inserts as needed.

**Epoxy for Rebar** Dimensional Lumber Hilti Hit HY 150 MAX Adhesive

Hem-fir No. 2 or SPF No. 2

**Bolts-Wood Construction** SAE Gr. 2 or Gr. 5

If there is a discrepancy between these material notes and the specifications, these notes shall supersede the specifications.

Bid Documents

AS SHOWN

**Quality Control** Drawn: GLC Checked: GLC Approved:

Project Number

201029

**Sheet Number** A-1.0

#### **MASONRY NOTES**

CMU walls to have net compressive strength = 1500 psi, locate bars in center of wall and solid grout all reinforced cores and all cores below grade. rebar lap length = 3'-0". provide additional #5 vertical bars at door jambs, corners and at ends of walls. all walls to be doweled to footing or thickened slab below. dowels may be drilled and epoxied into thickened slab in lieu of being cast in place.

Connect intersecting walls per MS-05

#### Provide vertical control joints at each corner and at 20' max intervals along walls.

## Slope slab to floor drains from corners of toilet and utility Slab jointing is suggested on the floor plan, Sheet A-1.0.

ROOF PLAN

SCALE 3/16" = 1'- 0"

Slab on grade to be 5" thick, with 4,000 psi concrete, reinforced

with 6x6 W2.9xW2.9 WWF, on polyethelene moisture barrier,

over 5" thick layer of free-draining compacted granular fill, on

compacted existing soil or engineered granular fill. Suitability

of existing soil for support of floor slab to be verified by a

geotechnical engineer prior to construction.

**SLAB-ON-GRADE NOTES** 

Roof over wood trusses to be 5/8" APA rated roof sheathing w/ H-clips and nailed w/ 10d @ 6" o.c.

WOOD ROOF AND FRAMING PLAN NOTES

Wood trusses to be designed and sealed by a P.E. licensed in the state of Michigan. see architectural drawings for profile of trusses, contractor to provide shop drawings indicating members, layout, connections, and relevant details for framing.

#### Design criteria as follows: dead load: 15 psf top chord + 15 psf bottom chord

B1-26, as well as any bracing specifically indicated in the shop drawings, shall remain installed as permanent bracing. Additional permanent bracing, if required, is noted on plans.

If piggy back trusses are provided, temporary bottom chord bracing requirements of HIB-91 diagram F apply in the plane where the upper and lower trusses meet.

Note lateral load framing proposed at gable end walls at top of CMU wall and gable end wood framing.

#### See wall sections for typical details for foundations.

All footings are proposed to be formed footings. Due to expected soil conditions, TRENCH FOOTINGS WILL NOT BE ALLOWED. Bottom of footing to be minimum of 48" below

Minimum bearing capacity for all footings to be 1000 PSF.

# -----14 Ceiling fan. 17 Shingled ridge vent. 2.7/8" TRENCH FOOTINGS NOT ALLOWED

REFLECTED CEILING PLAN


SCALE 3/16" = 1'- 0"

#### **DRAWING NOTES**

- 1 Reinforced concrete trench footing.
- 2 14" diameter X 42" deep bollard footing. See elevation, Sheet A-3.0
- 3 Typical reinforced concrete porch pier footing.
- 4 Gable end stud wall; 2 X 4's @ 16" OC. with 1/2" sheathing to align with face of CMU below.
- 5 Dormer stud wall; 2 X4 's @ 16" OC. with 1/2"
- sheathing. 6 Aluminum dormer vents; 3 per dormer.
- 7 2" perforated soffit vent; dark brown in color.
- 8 Typical porch pier.
- 9 Ceiling mounted toilet light.
- 10 Utility light; provide blocking as need to properly suspend. suspend above height of overhead door in up position.
- 11 No ceiling in utility room; trusses exposed.
- 12 Overhead door in up position.
- 13 Ceiling vent, typical. See mechanical plans.
- 15 Wall mounted exterior light.
- 16 Recessed downlight.
- 18 Dormer flashing and stepped counter flashing at dormer wall.
- 19 Flashing at face of dormer; flash over shingles.
- 20 100% ice & water shield at dormer roof.

## iBeckett&Raeder Landscape Architecture Planning & Engineering

Beckett & Raeder, Inc. 535 West William, Suite 101 Ann Arbor, MI 48103 734 663.2622 ph 734 663.6759 fx

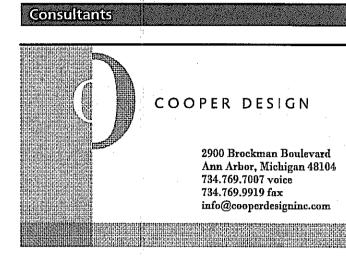

**Pittsfield Township Parks Parks Commission** 

## HICKORY WOODS PARK PHASE 1b IMPROVEMENTS

Bid Documents

Pittsfield Township, MI

02.22.11

Sheet Title
Restroom Building
FOUNDATION PLAN
REFLECTED CEILING PLAN
<b>ROOF FRAMING PLAN</b>
ROOF PLAN
Dates


AMMUNUMBUREERSSAAAAAAAAAAAAAAAAAAAAAAAAAAAAAAAAA	
1,127,100,100	
77-7618/1/2014	
984777778777777777777777777777777777777	
·	
<u></u>	


ale		
AS	SHOWN	

Drawn:	GLC	
Checked:	GLC	P. M. D. 1000 M. 1000 M. 100 M. 1
Approved:		

Project Number 201029

Sheet Number A-2.0

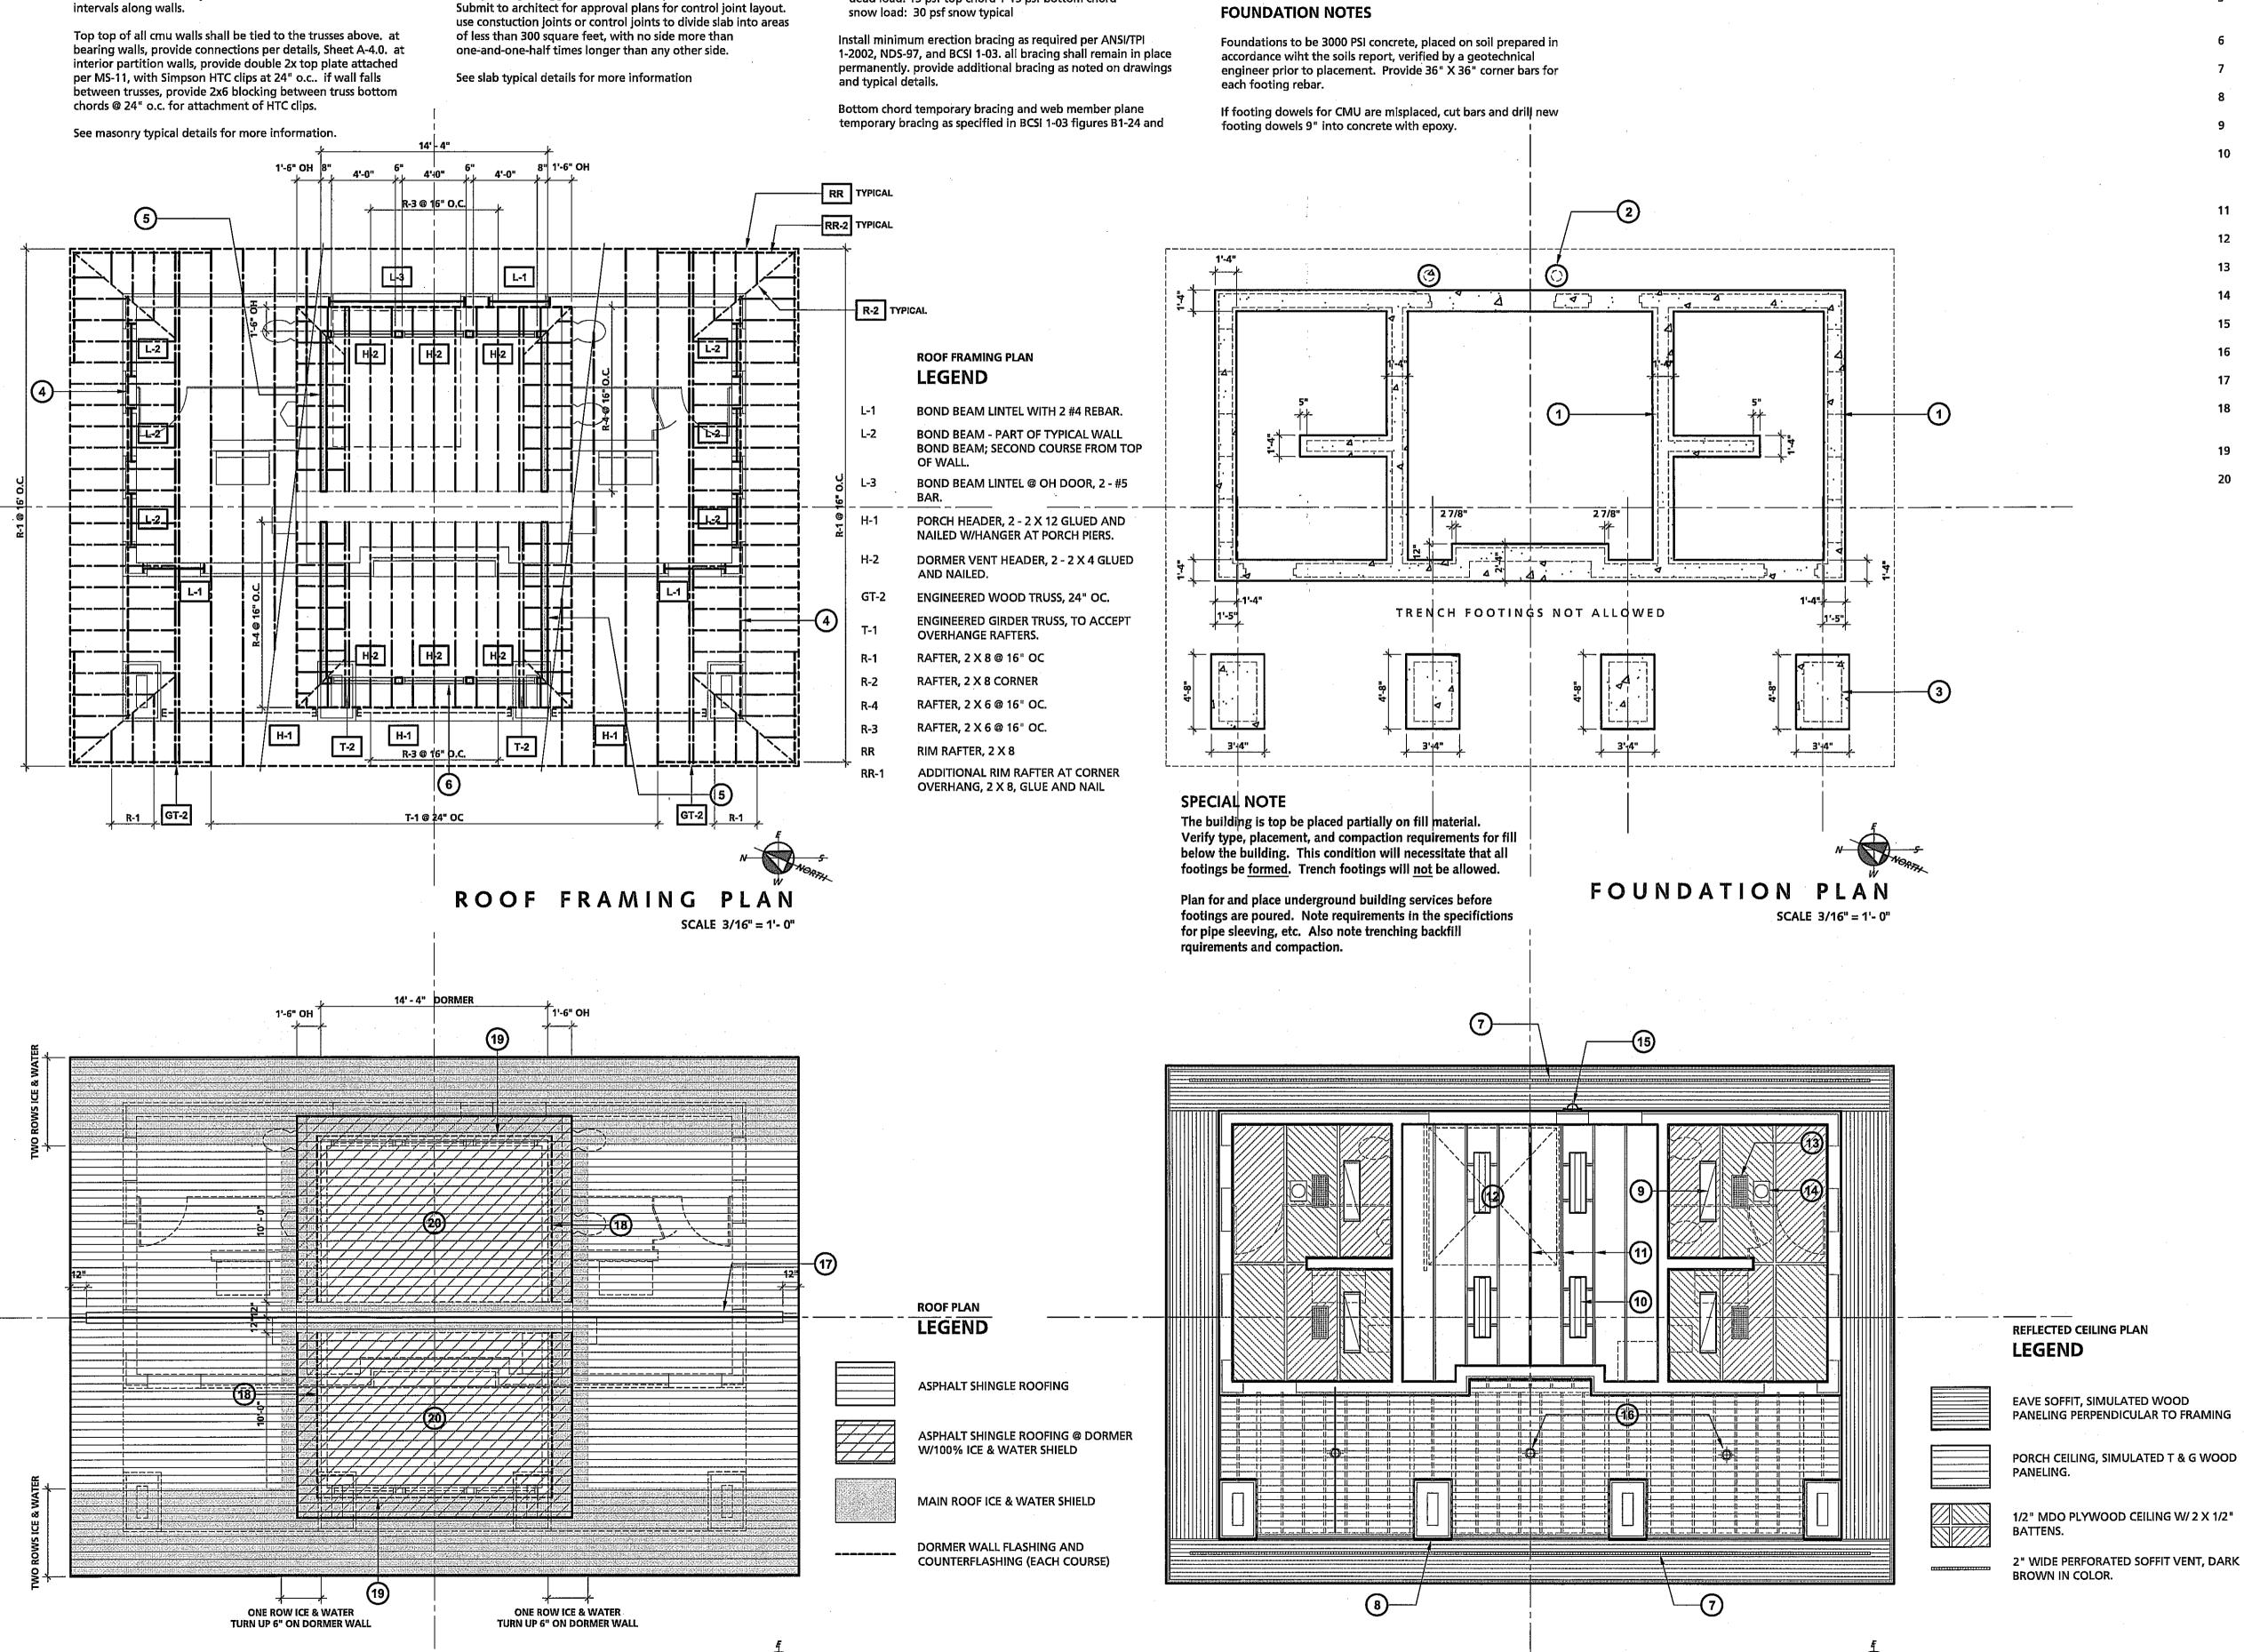

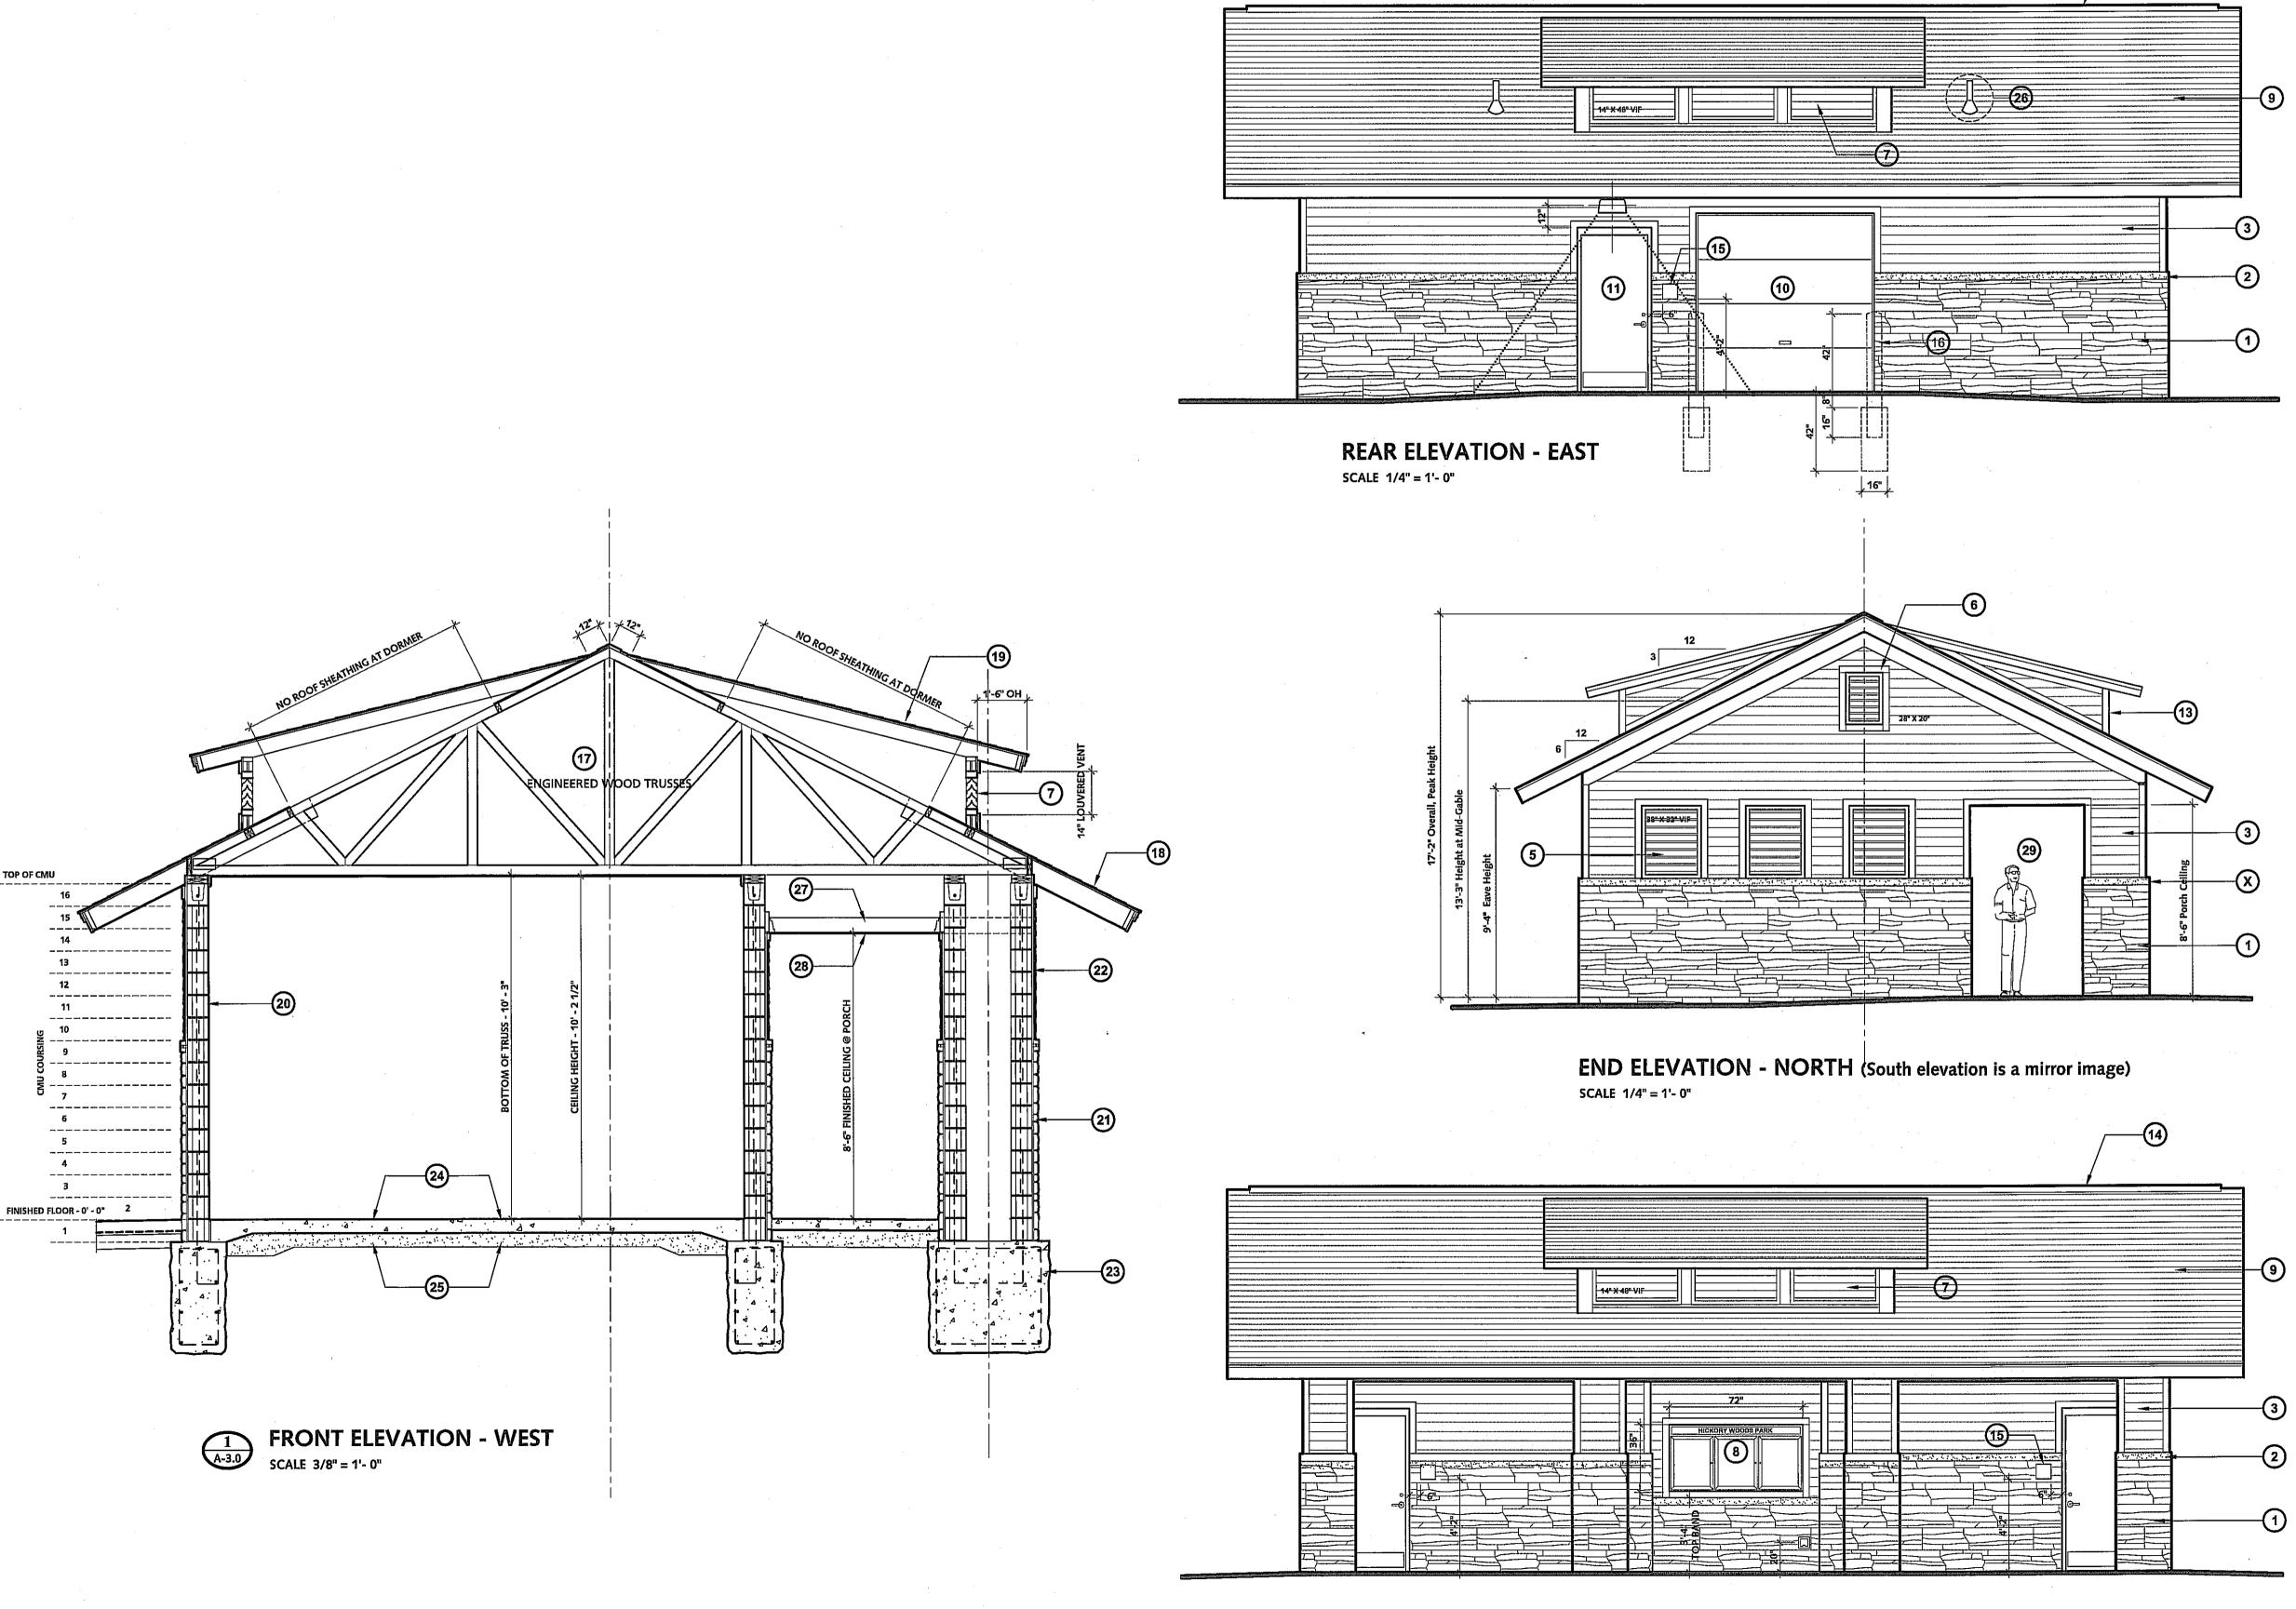

FRONT ELEVATION - WEST SCALE 1/4" = 1'- 0"

#### **DRAWING NOTES**


- 1 Simulated ashlar stone veneer.
- 2 Cast stone water table band.
- 3 Simulated wood siding; painted, with
- simulated wood trim; 5/4 X 4.
- 4 Covered, open porch.
- 5 Toilet vents; louvered vents; screened, sightproof, painted aluminum.
- 6 Gable end attic vent; louvered vents; screened, sightproof, painted aluminum.
- 7 Dormer attic vents; louvered vents; screened, sightproof, painted aluminum.
- 8 Bulletin board; aluminum frame, glass
- 9 Ashphalt shingle roof.
- 10 Sectional overhead door; pre-painted aluminum.
- 11 Painted hollow metal door.
- 12 Porch pier.
- 13 Dormer.
- 14 Shingled ridge vent.
- 15 8" X 8" Barrier-free door signage with braille. Provide stand-off ounting due to rough face of ashlar stone veneer.
- 8" diameter steel bollard with plastic sleeve; yellow. Install footing as shown: 16"dia. X 42" below grade (hold below slab). Embed steel bollard min. of 16" into foundation; 24" below grade. provide an expansion joint around each bollard, caulk.
- 17 Engineered roof trusses.
- 18 2 X 8 Eave outrigger.
- 19 Dormer roof.
- 20 typical reinforced 8" CMU wall.
- 21 Simulated stone veneer.
- 22 Cement board lap siding over 1 X furring.
- 23 Reinforced concrete pier trench footing.
- 24 Fiver reinforced concrete slab.
- 25 Compacted sand base.
- 26 Paint exposed PVC at roof vents medium brown to match roof.
- 27 2 X 6 wood ceiling framing at porch; 16" O.C. Install 2 X wall mounted 'nailer', use joist hangers to attach ceiling joists, as shown,
- 28 Cement board ceiling; manufacturer's standard soffit material.
- 29 Open porch.

B R (1)
Beckett&Raeder

Landscape Architecture
Planning & Engineering

Beckett & Raeder, Inc. 535 West William, Suite 101 Ann Arbor, MI 48103 734 663.2622 ph 734 663.6759 fx

#### Consultants

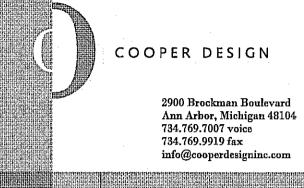

Seal

#### Project Title

Pittsfield Township Parks Parks Commission

# HICKORY WOODS PARK PHASE 1b IMPROVEMENTS

Pittsfield Township, MI

Sheet Title
Restroom Building

EXTERIOR ELEVATIONS & BUILDING SECTION


07 77 11	Bid Documents	
02.22.11	Bid Documents	
	'	
•		
	· · · · · · · · · · · · · · · · · · ·	

## Scale

Quality	Contro	
Drawn:	GLC	
Checked:	GLC	

Project Number 201029

A-3.0

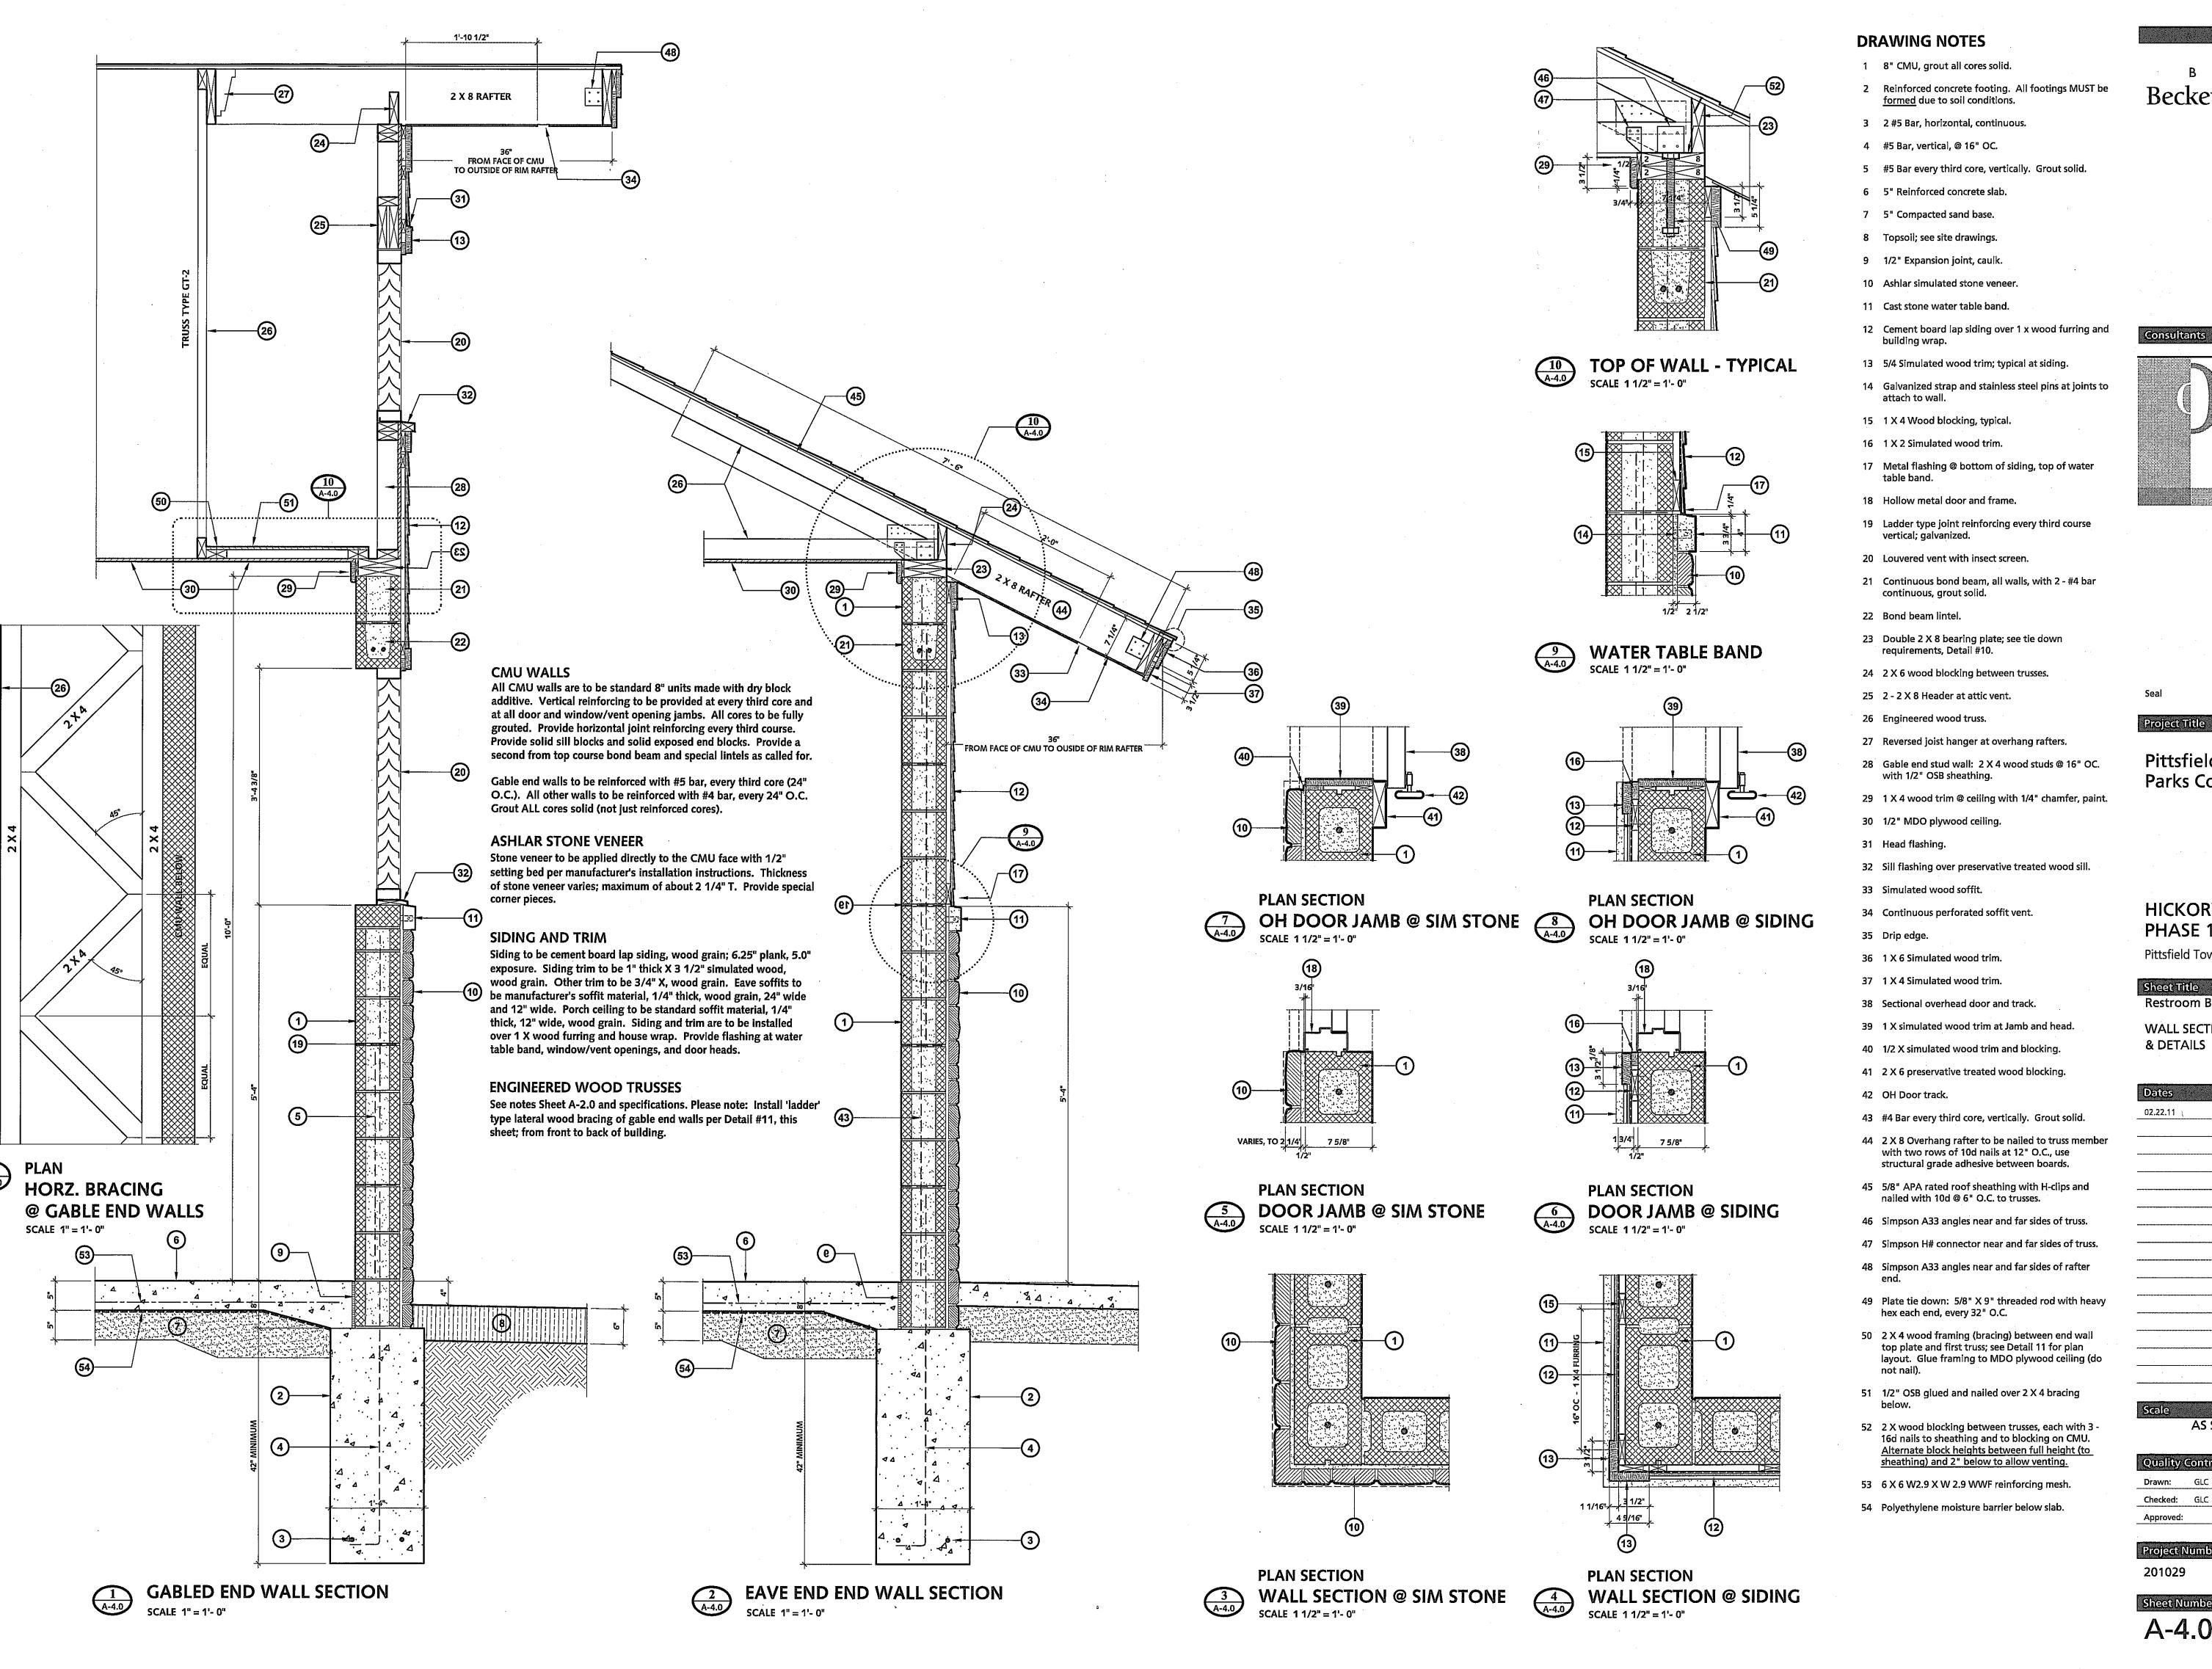

Beckett&Raeder Landscape Architecture Planning & Engineering

> Beckett & Raeder, Inc. 535 West William, Suite 101 Ann Arbor, MI 48103

734 663.2622 ph 734 663.6759 fx

COOPER DESIGN 2900 Brockman Boulevard Ann Arbor, Michigan 48104 734.769.7007 voice 734.769.9919 fax info@cooperdesigninc.com

Project Title

Pittsfield Township Parks **Parks Commission** 

HICKORY WOODS PARK PHASE 1b IMPROVEMENTS

Pittsfield Township, MI

Sheet Title Restroom Building

**WALL SECTIONS** 

& DETAILS

Bid Documents

Quality Control Drawn: GLC Checked: GLC


Project Number

**Sheet Number** 

A-4.0

## **DRAWING NOTES**

- 1 1 X Wood trim wuth 1/4" chamfer, paint.
- 2 Site-proof, painted aluminum louvered vents with insect screens.
- 3 Wall mounted mirror.
- 4 Wall mounted baby changing station .
- 5 Floor mounted and overhead braced toilet partitions.
- 6 Wall mounted electric hand dryer.
- 7 Aluminum frame; clear anodized.
- 8 Header with vinyl message panel.
- 9 Door panel with laminated safety glass; each cabinet. Tack board surface inside of each of three cabinets.
- 10 Keyed lock; each door.
- 11 Solid CMU sill block, typical.
- 12 Insulation at water supply and drain piping in accordance with Michigan Barrier-free Design Requirements; see Plumbing Plans, typical.
- 13 Overhead partition bracing.

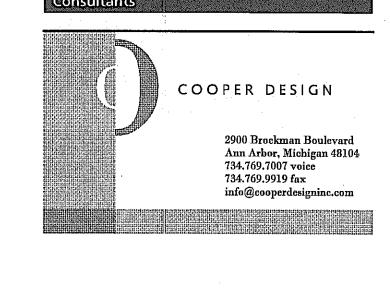

Beckett&Raeder

Landscape Architecture Planning & Engineering

Beckett & Raeder, Inc. 535 West William, Suite 101 Ann Arbor, MI 48103

734 663.2622 ph 734 663.6759 fx



**EQUAL** 

## EXTERIOR BULLETIN BOARD


**EQUAL** 

**HICKORY WOODS PARK** 

SCALE 1" = 1'- 0"

#### **BULLETIN BOARD NOTE**


Mount bulletin board directly to 1 X furring at CMU wall. Trim around it with cement board trim (5/4 X 4 all sides) and siding as shown on exterior elevations. Provide flashing at water table band.

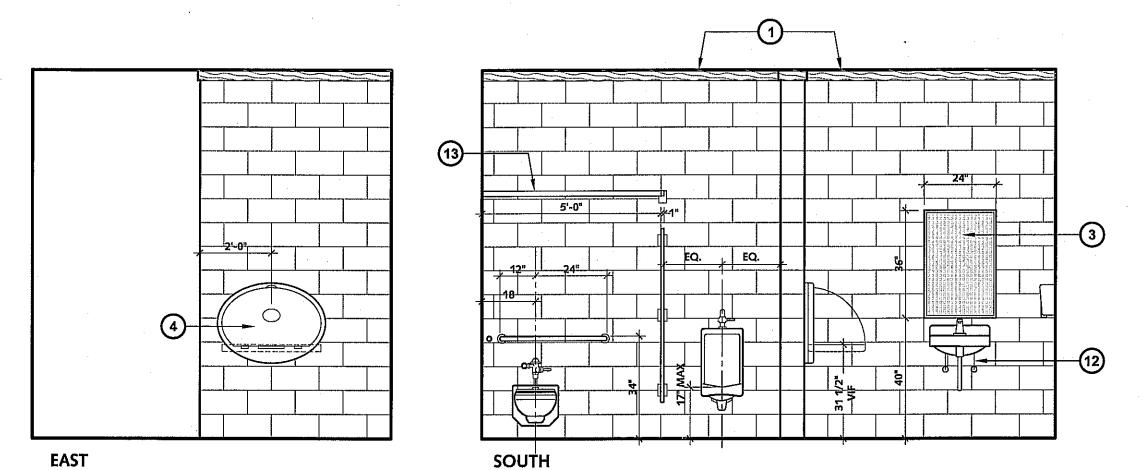


MEN'S TOILET ELEVATIONS


SCALE 1/4" = 1'- 0"


EQUAL

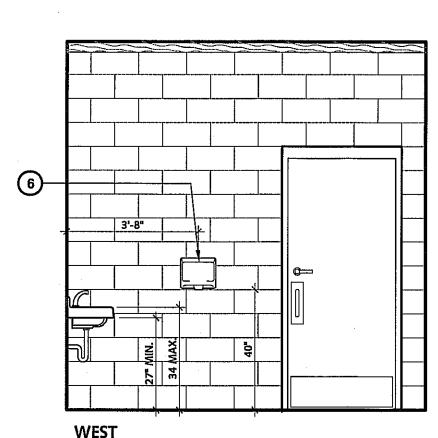

NORTH

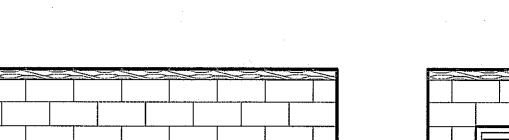

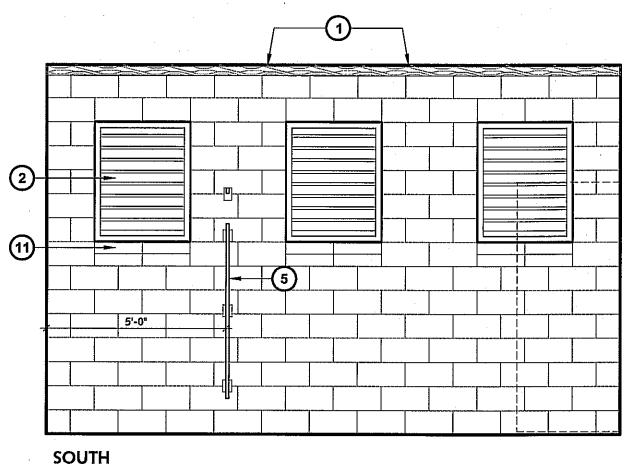

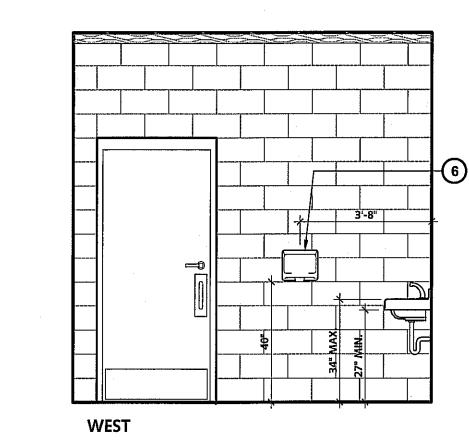

SCALE 1/4" = 1'- 0"

## Pittsfield Township Parks Parks Commission

## HICKORY WOODS PARK PHASE 1b IMPROVEMENTS

Pittsfield Township, MI

#### Sheet Title Restroom Building

INTERIOR ELEVATIONS & DETAILS


02.22.11	Bid Do	cuments			
			<del></del>		
		· 		***************************************	
				<del></del>	
<del></del>					<u></u>
· · · · · · · · · · · · · · · · · · ·		vr	<del></del>	***************************************	
	<del></del>				

#### AS SHOWN


Drawn:	GLC	 <b></b>	 
Checked:	GLC		
Approved:			


#### Project Number 201029

**Sheet Number** A-5.0

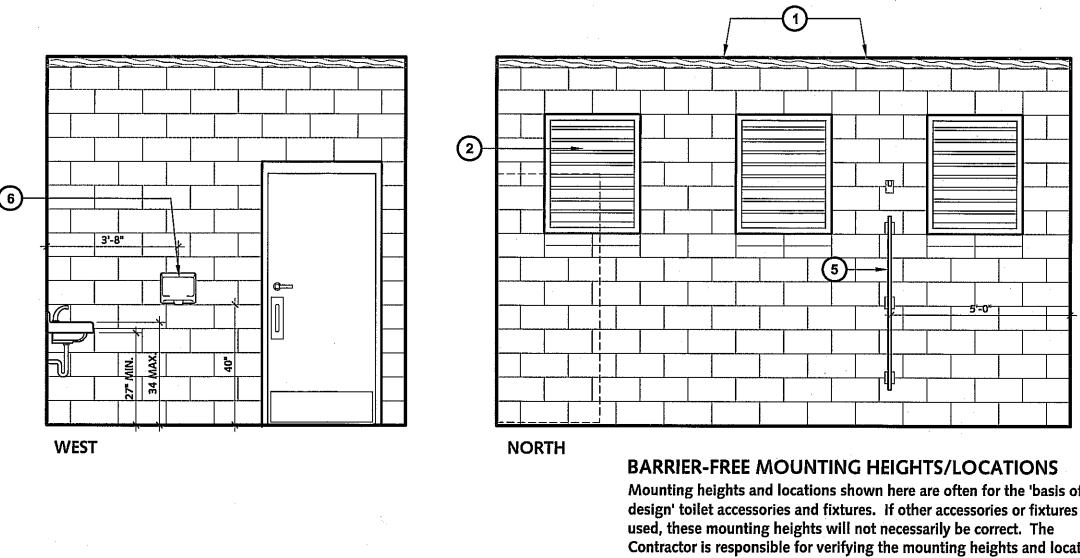


Mounting heights and locations shown here are often for the 'basis of design' toilet accessories and fixtures. If other accessories or fixtures are used, these mounting heights will not necessarily be correct. The Contractor is responsible for verifying the mounting heights and locations of all toilet room fixtures and accessories to insure that they meet the Michigan Building Code - 2006, Barrier-free Design Requirements.

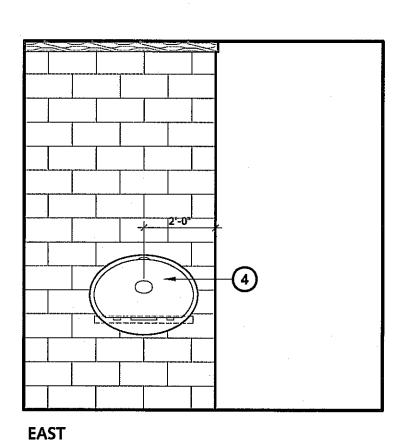

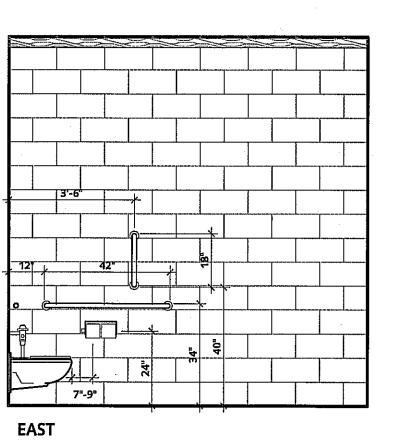

**EAST** 

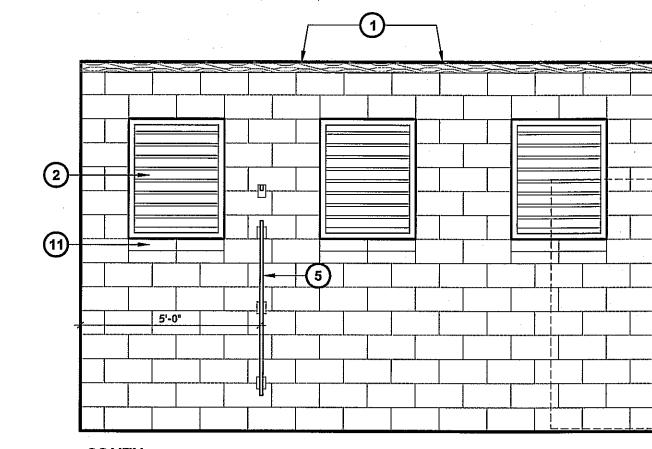

WOMEN'S TOILET ELEVATIONS